THE IDEAS AND DESIGN CONCEPTS EXPRESSED HEREIN AND THE GRAPH-ICALLY DISPLAYED ARRANGEMENT OF THEIR COMPONENTS REPRESENTED BY THIS DRAWING HAVE BEEN
DEVELOPED FOR THE EXCLUSIVE USE OF THE SPECIFIED PROJECT AND ARE THE SOLE PROPERTY OF JMP Design & Build, Inc.
INCORPORATED. A CONVEYANCE OR DISCLOSURE OF THE IDEAS DESIGN CONCEPTS OR USE OF ANY GRAPH ICALLY DISPLAYED ARRANGEMENTS OF THE COMPONENTS SHALL BE AT THE DISCRETION AND ONLY THROUGH THE EXPRESSED WRITTEN CONSENT OF JMP Design & Build, Inc. ALL MATERIALS HEREIN ARE PROPRIETARY AND COPYWRITTEN

PROJECT

BUILDER DEL VALLO BUILDING

& CONSTRUCTION INC. 53750 N. FOSTER RD. CHESTERFIELD TWP. 48051 PH. 586-634-4429

PRELIMINARY CONSTRUCTION

14'-4"

6'-0" x 5'-0"

GR BELOW

36" hgt. WD. — HANDRAIL

DN. 15 RISERS

HANDRAIL

OPEN TO FOYER BELOW

LNDRY.

DRYR.

5'-0" x 5'-0"

(2) 2x12 EGRESS

MASTER BEDROOM 8'-1 1/8" BRG. HGT.

BEDROOM #2 8'-1 1/8" BRG. HGT.

GIRDER TRUSS = === = === =

EGRESS 5'-0" x 5'-0"

SECOND FLOOR PLAN

PRE-ENG. TRUSSES

@ 24" O.C.

47'-6"

SHOWER CURB +

- . ALL WORK TO COMPLY WITH ALL NATIONAL, STATE AND LOCAL CODES, ORDINANCES, LAWS AND REGULATIONS THAT ARE APPLICABLE. THE CONTRACTOR SHALL NOTIFY MISS DIG (1-800-482-7171)
- AT LEAST 72 HOURS PRIOR TO THE START OF CONSTRUCTION.
- THE CONTRACTOR SHALL FIELD YERIFY THE SIZES, LOCATIONS, ELEVATIONS AND DETAILS OF THE EXISTING CONDITIONS THAT
- AFFECT THE WORK AND SHALL INFORM THE ARCHITECT OF ANY DISCREPANCIES IN DIMENSIONS, SIZES, LOCATIONS AND CONDITIONS BEFORE PROCEEDING WITH THE WORK. THE CONTRACTOR SHALL PROVIDE ALL SHORING, BRACING, AND
- UNDERPINNING AND ALL MEANS REQUIRED TO PROTECT AND MAINTAIN THE SAFETY, INTEGRITY AND STABILITY OF ALL NEW CONSTRUCTION,
- THE CONTRACTOR SHALL FAMILIARIZE HIMSELF/HERSELF WITH THE EXISTING CONDITIONS OF THE BUILDING INCLUDING UTILITIES, SERVICES, ETC. AND SHALL BE FULLY RESPONSIBLE FOR ANY UNAUTHORIZED DISRUPTION TO THE OWNER'S NORMAL USE OF UTILITIES, SERVICES, AND THE SURROUNDING FACILITIES.
- THE CONTRACTOR/OWNER SHALL FAMILIARIZE HIMSELF/HERSELF WITH THE CONSTRUCTION DOCUMENTS, SIZES AND LOCATIONS OF ANY DISCREPANCIES IN DIMENSIONS, SIZES AND LOCATIONS BEFORE PROCEEDING WITH THE WORK.

ARCH FAULT CIRCUIT INTERRUPTER

THE SYSTEM IS NOT IN USE.

CIRCULATING HOT WATER SYSTEMS:

PROTECTION IN THE ENTIRE CIRCUIT E3802.11.

ALL CIRCULATING SERVICE HOT WATER PIPING

ACCESSIBLE MANUAL SWITCH THAT CAN TURN

OFF THE HOT WATER CIRCULATING PUMP WHEN

SHALL INCLUDE AN AUTOMATIC OR READILY

SMOKE DETECTORS & CARBON MONOXIDE DETECTOR SMOKE ALARMS SHALL BE INSTALLED IN THE FOLLOWING LOCATIONS: -IN EACH SLEEPING ROOM

8'-101/2"

22" x 30" ATTIC ACCESS

SEALED TO CONFORM

SCUTLE TO BE

TO MUEC 2015

BEDROOM #3

8'-1 1/8" BRG. HGT.

OPTIONAL ---

SECOND SINK

- OPTIONAL

LINE OF GARAGE BELOW

ELEVATION C

SECOND SINK

MS. BATH

W.I.C.

-OUTSIDE EACH SEPARATE SLEEPING AREA IN THE IMMEDIATE VICINITY

-ON EACH ADDITIONAL STORY OF THE DWELLING, INCLUDING BASEMENTS BUT NOT INCLUDING CRAWL SPACES OR UNINHABITABLE ALL SMOKE DETECTORS SHALL BE INTERCONNECTED AN

CARBON MONOXIDE DETECTORS SHALL BE LOCATED IN THE NEAR VICINITY OF EACH BEDROOM AND IN BASEMENT 15'-0" FROM FUEL FIRED OR HEATED UNIT.

MRC 2015 SEC R 315

HAVE A BATTERY BACKUP.


ELEVATION C DRAWN BY: 04-01-2021 J.G. 04-07-2021 08-25-2021

SHEET TITLE:

FLOOR PLANS

CHECKED BY: J.M.P. JOB NUMBER: 21 – 132

SHEET NUMBER:

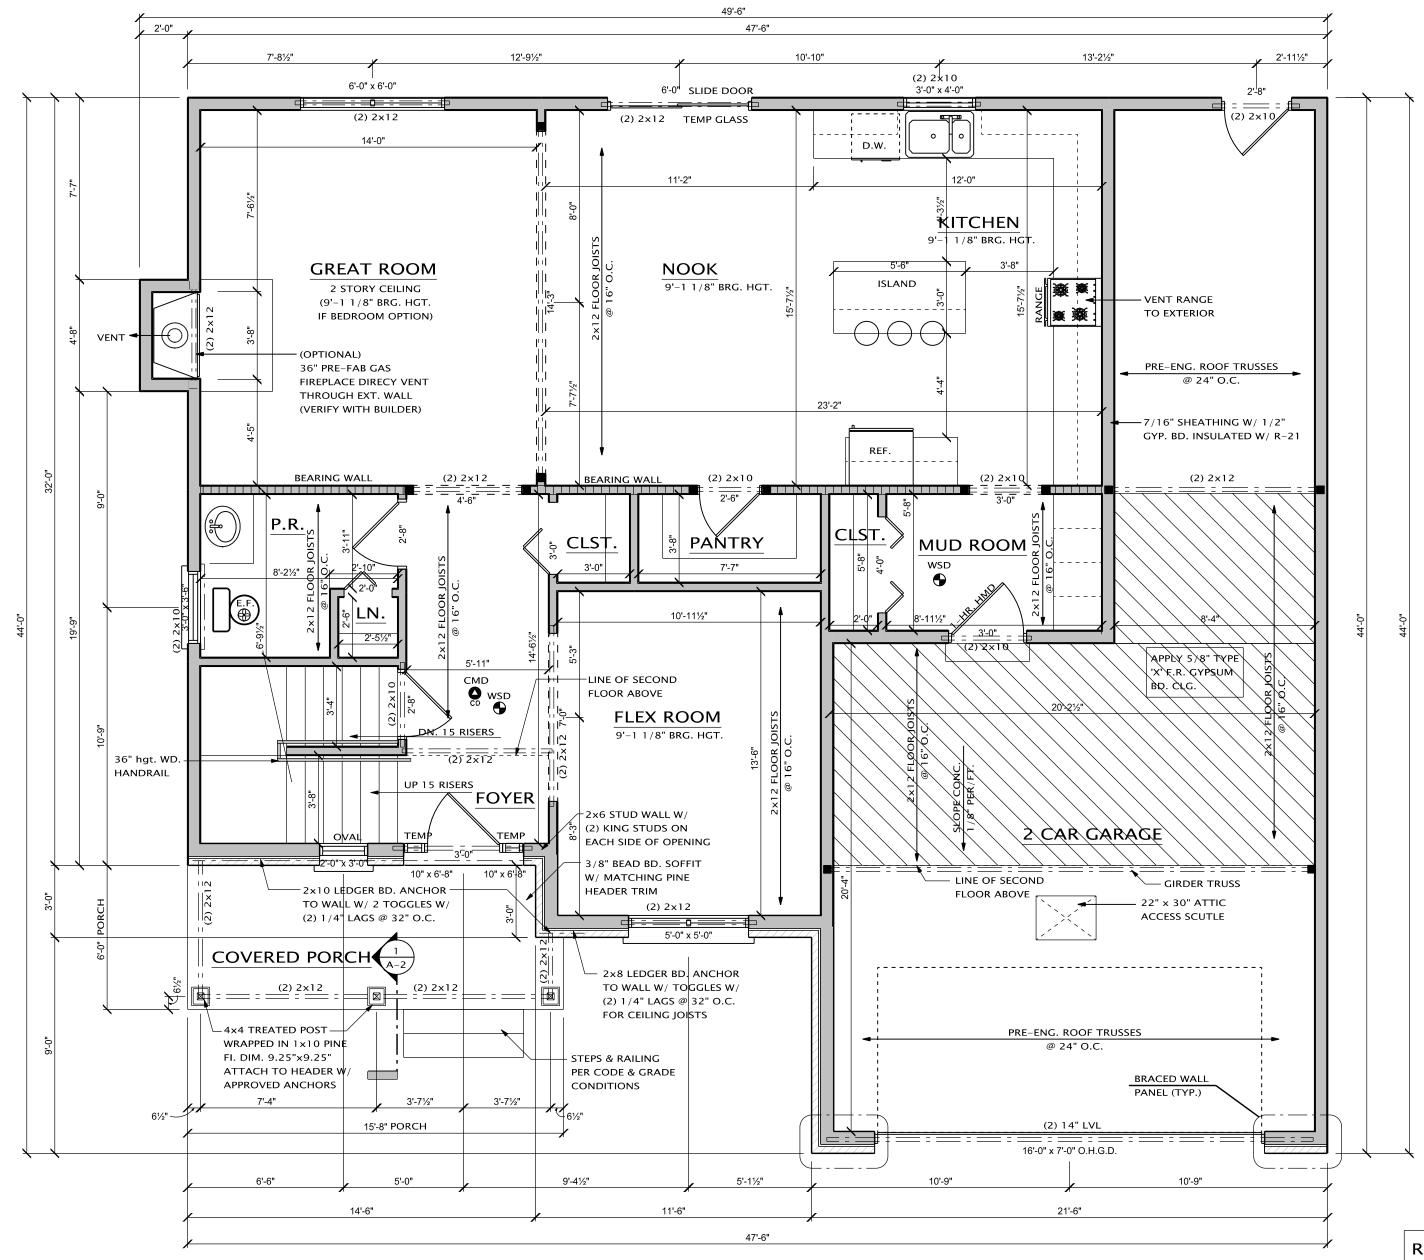

VENT DRYER— TO EXTERIOR

REFER TO SHEET A-7 FOR ELEVATIONS

ALL EXTERIOR WALLS TO

BE 2x6 CONSTRUCTION

ALL DIMENSIONS

UNLESS NOTED OTHERWIS

TAKEN FROM SHEETROCK

ALL GARAGE EXTERIOR WALLS

TO BE 2×6 CONSTRUCTION

ELEVATION C ALL HEADERS TO BE 2x12

NOTES

FIRST FLOOR PLAN

1,170 S.F.

2,245 S.F.

FIRST FLOOR:

SECOND FLOOR: 1,075 S.F.

ALL ARCHWAYS SHALL BE FLAT UNLESS OTHERWISE NOTED.

SCALE: 1/4" = 1'-0"

- . ALL 1ST FLOOR EXTERIOR WALLS TO BE 2x6 STUDS @ 16" O.C.
- 3. ALL WET AREAS TO RECEIVE 1/2" DURAROCK SHEATHING.
- 4. ALL HEADERS NOT NOTED SHALL BE (2) 2x12's UNLESS NOTED OTHERWISE.
- 5. ALL WALLS OVER 12'-O" SHALL BE 2x6.

ON SITE FOR ROUGH INSPECTION.

6. ALL CONCEALED WALL SPACES SHALL BE FIRESTOPPED @ 8'-O" INTERYALS

. TRUSS DRAWINGS AND FLOORING SYSTEMS ARE TO BE

UNLESS NOTED OTHERWISE PROVIDE 2x4 BLOCKING @ 16" O.C. BELOW ALL NON-BEARING WALLS THAT RUN PARALLEL TO FLR. JST

NOTE TO CARPENTER VERIFY HEIGHT OF ARCHWAYS WALLS OVER 10'-0" HAVE BEEN WITH BUILDER, BUILDER TO DESIGNED FOR LATERAL WIND

AND ANY WALLS OVER 8'-0" IN HGT.

PROVIDE WINDOW SCHEDULE AND LOAD/SHEAR & WILL SUPPORT DOOR SCHEDULE W/ ROUGH OPENING | ALL IMPOSED LOADS.

- PROVIDE TEMPERED GLASS: . WHEN GLASS IS 18" OR LOWER A.F.F. 2. ANY DOOR THAT HAS GLASS CONSTRUCTION
- 3. WITHIN 36" OF A DOOR OR SWING . WITHIN THE NEAR VACINITY OF TUB OR SHOWER AND LESS THAN 60" FROM FLOOR OR PLATFORM SURFACE. 5. WINDOWS IN STAIR LANDINGS 60" OR LESS A.F.F.

THE BOTTOM OF THE WINDOW IS 72" OR MORE ABOVE GRADE, SHALL BE

STUD, TYP, ALL BEARING WALLS OPERABLE WINDOW NOTE: ALL WINDOWS THAT ARE OPERABLE AND

ALL BEARING WALLS SHALL HAVE

FLOOR JOIST UNDER EACH BEARING

24" ABOVE FINISH FLOOR TO THE BOTTOM OF THE WINDOW.

GENERAL NOTES

- THE CONTRACTOR SHALL OBTAIN ALL REQUIRED PERMITS AND CALL FOR REQUIRED INSPECTIONS.

- THE CONTRACTOR/OWNER SHALL INDEMNIFY THE ARCHITECT FROM ERRORS AND OMISSIONS WHICH CAN OR MAY OCCUR DURING

THE PREPERATION OF THESE DOCUMENTS.

HARD WIRED AND BATTERY BACK-UP. BACK UP

L BRANCH CIRCUITS THAT SUPPLY 125 VOLT SINGLE PHASE 15 & 20	
IP. OUTLETS INSTALLED IN DWELLING UNIT BEDRM. SHALL BE	
OTECTED BY ARC-FAULT CIRCUIT INTERRUPTER LISTED TO PROVIDE	