## **CODE COMPLIANCE GENERAL NOTES:**

(REFER TO NOTES ONLY APPLICABLE TO PROJECT) MICHIGAN RESIDENTIAL CODE 2015 MICHIGAN PLUMBING CODE 2015 MICHIGAN MECHANICAL CODE 2015 MICHIGAN ELECTRICAL CODE 2014 MICHIGAN UNIFORM ENERGY CODE 2015

2x10 FLOOR JOISTS @ 12" O.C. UNDER ALL THE TILE OR MARBLE FLOORS 20 LB. DEAD LOAD REQUIRED.

2. ALL POURED CONCRETE WALLS TO BE BACKFILLED WITH SANDY TYPE SOIL AND BE WELL BRACED UNTIL CONCRETE IS THOROUGHLY CURED

AND ADDITIONAL WEIGHT OF THE BUILDING IS IN PLACE. 3. ALL FLOOR JOISTS TO BE #2 OR BETTER HEM FIR W/ 1"x3" CROSS BRIDGING

@ 8'-0" O.C. AT 1/3 POINTS OF SPAN. 4. ROOF TRUSS DESIGNED BY TRUSS MANUFACTURER TO CONFORM TO ALL MINIMUM DESIGN LOAD REQUIREMENTS. BRACE ROOF TRUSSES AS REQUIRED

BY MANUFACTURER.
5. ROOF TRUSS FRAMING INDICATING ON DRAWINGS ON DRAWINGS IS ARE ASSUMED LAYOUT. TRUSS MANUFACTURER SHOULD REVIEW THE DRAWING AND INDICATE TO ARCHITECT/DESIGNER PRIOR TO FABRICATION ANY CHANGE IN BEARING CON-

DITIONS THAT WOULD REQUIRE RE-FRAMING OF OUR STRUCTURE TO ACCOMODATE 6. ALL POURED CONCRETE FOOTINGS TO BE A MINIMUM OF 3'-6" BELOW FINISHED

GRADE BEARING ON UNDISTURBED VIRGIN SOIL WITH A MINIMUM BEARING CAPACITY OF 2,000 PSF MUST BE VERIFIED BY SOILS ENGINEER IN THE FIELD FOR FOOTING

7. ALL POURED CONCRETE WALLS WITH 7'-0" OR MORE BACKFILL TO BE REINFORCED WITH #4 BARS @ 16" O.C. VERTICALLY WITH ONE #4 BAR TOP & BOTTOM OF WALL

HORIZONTALLY. FOOTING INSPECTOR TO VERIFY IN FIELD.

8. ALL WINDOW NUMBERS REFER TO ANDERSON 100 SERIES WINDOWS. IF ALTERNATE WINDOW MANUFACTURER IS USED. ALL SIZES & SHAPES TO MATCH DIMENSIONALLY. ALL ENGINEERED WOOD FLOOR TRUSSES TO BE #1 DENSE K.D. WITH 2" BY 6" CON-

TINUOUS RIBON BRACING ON BOTTOM CHORD 8'-0" O.C. (MINIMUM 2 PER SPAN) WELL NAILED TO TRUSSES, PROVIDE DRAFT STOPPING. 10. THE ROOF TRUSS MANUFACTURER TO FURNISH SHOP DRAWING TO THE ARCHITECT/

DESIGNER PRIOR TO FABRICATION OF THE TRUSSES.

11. ALL MICRO-LAM BEAMS TO BE JOINED TOGETHER PER MANUFACTURERS' SPECIFICAIONS. 12. ALL POURED CONCRETE WALLS WITH BRICK LEDGE GREATER THAN 4'-0" SHALL BE RE-

INFORCED WITH #5 BARS 24" O.C. VERTICALLY WITH ONE #4 BAR TOP & BOTTOM OF WALL 13. DO NOT SCALE DRAWINGS. USE PRINTED DIMENSIONS ONLY. IF ANY DISCREPANCY OCCURS, NOTIFY THE ARCHITECT/DESIGNER IMMEDIATELY FOR DIRECTION. THE BUILDER IS RESPONSIBLE FOR REVIEWING ALL DRAWINGS AND IF ADDITIONAL CLARIFICATION OR INFORMATION IS NEEDED, BUILDER IS TO CONTACT THE ARCHITECT/DESIGNER AND SALES

14. PROVIDE 15 POUND FELT AT UNTREATED EXPOSED LUMBER. 15. ALL BEDROOM WINDOWS TO MEET 2015 MICHIGAN RESIDENTIAL EGRESS CODES. ALL WINDOW

OF 24" ABOVE FINISH FLOOR OF THE ROOM PER MRC 2015 16. PROVIDE FIBER CEMENT, FIBER MAT REINF, CEMENT, GLASS MAT GYPSUM BACKERS OR FIBER REINF. GYPSUM BACKERS AS BACKERS FOR TUB AND/OR SHOWER WALL

TILES AND PANELS. BACKERS MUST COMPLY WITH ATSM C1288, C 1325, C1178 AND BE INSTALLED PER MANUFACTURERS' RECOMMENDATIONS. 7. WHERE HANDRAILS ARE SHOWN, HANDRAIL HEIGHTS ARE TO NOT BE LESS THAN 34" A.F.F. & MORE

SILLS, 72" ABOVE FINISH GRADE, SHALL AHVE THE BOTTOM F THE OPENING LOCATED A MINIMUM

THAN 38" A.F.F. GUARD RAIL IS TO BE NOT LESS THAN 36" A.F.F.

(MRC 2015) PROVIDE HANDRAIL ON AT LEAST (1) SIDE OF EVERY STAIRWAY PER SECTION R311.7.7

OF THE 2015 MICHIGAN RESIDENTIAL CODE. HANDRAIL GRIP TO COMPLY WITH 2015 MICHIGAN

18. DO NOT DRILL KITCHEN WINDOW DOUBLERS.
19. PROVIDE A BATH FAN WHERE SHOWN ON PLAN AND VENT FAN TO EXTEIOR AS REQUIRED.

20. TYPICAL ALL HABITABLE ROOMS TO HAVE PROPER LIGHT AND VENTILATION AND COMPLY WITH 2015 MICHIGAN RESIDENTIAL CODES.

I. PROVIDE ELECTRICAL SMOKE DETECTORS IN ALL SLEEPING AREAS, HALLWAYS, AND MECHANICAL

ROOMS ON ALL FLOOR LEVELS, INCLUDING THE BASEMENT. SMOKE DETECTORS SHALL BE WIRED TOGETHER SO AS WHEN ONE SOUNDS, THEY ALL SOUND AND HAVE BATTERY BACKUP PER SEC 314 OF 2015 MICHIGAN RESIDENTIAL CODE.
22. PROVIDE ADEQUATE ROOF VENTILATION AND SOFFIT VENTILATION (MIN.) AS REQUIRED. VERIFIED

BY CALCULATION 1/300 OF THE AREA VENTILATION REQUIRED 23. TYPICALLY ALL PINS IN POURED CONCREETE FOUNDATION WALLS MUST BE REMOVED AND FILLED

WITH FOUNDATION COATING PRIOR TO BACK FILL INSPECTION. 24. PROIVDE METAL FLASHING, COUNTER FLASHING AND STEPPED FLASHING WHERE NOTED AND BRICK AND SIDING MEET

25. PROVIDE APPROVED SEALANT WHERE REQUIRED AND AS DETAILED BY MANUFACTURER. 26. VERIFY ELECTRICAL SERVICE IN ACCOMMODATING ALL NEW WORK. VERIFY ALL PROPOSED ELECTRICAL OUTLETS, SWITCHES, DIMMERS, LIGHT LOCATION, ETC. INCLUDING CABLE AND PHONE PRE-WIRING SECURITY. TAKE INTO CONSIDERATION ALL ELECTRICAL INSTALLATION WITH

OWNER AND COMPLY WITH 2015 MICHIGAN RESIDENTIAL ELECTRICAL CODES. . VERIFY FIREPLACE OPTION WITH SUBDIVISION SPECS. AND WORK ORDER. 8. PROVIDE 2-LAYER MINERAL COATED ROLLED ROOFING AT ALL EAVES TO 24" INSIDE BULIDING.

2-LAYERS MUST BE CEMENTED TOGETHER VERIFY WITH BUILDING DEPARTMENT 29. PROVIDE 2x6 WOLMANIZED PRESSURE TREATED SILL PLATE ON FIBERGLASS SILL SEALER WITH 1/2 INCH ANCHOR BOLTS AT 6'-0" O.C. AND LOCATED NOT MORE THAN 12" INCHES AND NOT LESS THAN 3-1/2 INCHES FROM THE ENDS OF EACH PLATE SECTION. EXCEPTION: USE ANCHOR

STRAPS, SPACED AT 3'-6" O.C. TO PROVIDE EQUIVALENT ANCHORAGE TO 1/2" ANCHOR BOLTS. 30. PROVIDE 4" PERIF. DRAIN TILE CONT. AT BASEMENT/CRAWL SPACE FOOTING IN 12" (MIN) PEASTONE W/ 2" BELOW DRAIN TILE. CONNECT TO SUMP AND STORM SEWER AS REQUIRED.

1. 6'-8" CLEAR HEADROOM REQUIRED ON ALL STAIRS. 2. CHIMNEY TERMINATION MUST PROJECT 2 FEET ABOVE ANY PART OF THE BULDING WITHIN

33. FIRESTOP ALL DROPS AND CHASES, ELECTRICAL, PLUMBING AND H.V.A.C. 34. PROVIDE 1/2 INCH DRYWALL ON THE GARAGE SIDE OF WALLS COMMON TO RESIDENCE AND GARAGE. APPLY 5/8" TYPE 'X' DRYWALL TO GARAGE CEILINGS AREAS BELOW

HABITABLE ROOMS PER MRC 2015. 35. LOWER LEVEL AREA CONSIDERED UNHABITABLE. ANY FUTURE MODERATIONS TO MODIFY

LOWER LEVEL TO A HABITABLE SPACE WILL COMPLY STRICLY TO THE 2015 MRC. EGRESS WINDOW(S) PROVIDED AS REQUIRED IN COMPLIANCE WITH MRC 2015.

36. AREAS THÁT REQURE TEMPERED GLASS: A. FIXED AND SLIDING PANELS OF SLIDING TYPE DOORS. B. SHOWER AND BATHTUB DOORS AND ENCLOSURES (IF APPLICABLE)

C. PANELS WITH A GLAZED AREA IN EXCESS OF 9 SQ. FT. WITH LOWEST RIDGE LESS THAN 18 INCHES ABOVE THE FINISHED FLOOR LEVEL.
D. ALL OTHER AREAS AS CODE REQUIRES PER 2015 MRC.

37. ROOF VENTILATION WHERE EAVE OR CORNICE VENTS ARE INSTALLED INSULATION SHALL

NOT BLOCK THE FREE FLOW OF AIR. A MINIMUM OF A 1 INCH SPACE SHALL BE PROVIDED BETWEEN THE INSULATION AND THE ROOF SHEATHING AT THE LOCATION OF THE VENTS. 8. ALL STAIRWAYS SHALL BE ILLUMATED WITH MIN (1) FOOT CANDLE OF LIGHT.

39. PROVIDE UNDERSTAIR PROECTION PER MRC 2015 ÉNCLOSED ACCESIBLE SPACE UNDER

SHALL HAVE WALLS. UNDER STAIR SURFACE AND ANY SOFFITS PROTECTED ON THE ENCLOSED SIDE WITH 1/2 INCH GYPSUM BOARD.

40. UNEXCAVATED GARAGE SLAB SHALL COMPLY WITH TABLE R402.2 4 INCH CONCRETE SLAB

MIN. 3,500 MINIMUM SPECIFIED COMPRESSIVE STRENGTH OF CONCRETE ON 4 INCHES MIN. WELL COMPACTED SAND BASE.

41. PROVIDE NON-ABSORBENT FINISH, TO THE SURFACE OF ALL BATHING AREAS WITH WALL MOUNTED SHOWER HEADS, A MIN. 6'-0" ABOVE FINISH FLOOR PER MRC 2009 SEC. R307.2. 42. PROVIDE A 1-3/8 INCH MIN. SOLID CORE FIRERATED DOOR BETWEEN GARAGE AND RESIDENCE

43. BUILDER AND SUB-BRICK CONTRACTORS TO PROVIDE WEEP HOLES RESTING ON THE FLASHING SPACED 32" O.C. MAX. (24 INCHES PREFERRED) AT THEAD DETAILS OF: WINDOWS, DOORS. BASEMENT WINDOWS AND GARAGE DOORS. ALSO PROVIDE FLASHING TO FACE OF BRICK WITH

MIN. 8 INCHES VERTICAL LEG AND FORM END DAMS (LAP UNDER AIR/MOISTURE BARRIER). MICHIGAN RESIDENTIAL CODE 2015, A PRE-BRICK INSPECTION WILL BE REQUIRED PRIOR TO BRICK INSTALLATION FOR FLASHING INSPECTION. 44. FASTENER SCHEDULE FOR STRUCTURAL MEMBERS TABLE R602.3 (1) WOOD STRUCTURAL

PANELS, SUBFLOOR, ROOF AND WALL SHEATHING TO FRAMING, BUILDING MATERIALS OF 5/16 INCHES TO 1/2 INCHES USE 6D COMMON NAIL (SUBFLOOR, WALL) AT 6 INCHES FROM EDGES 12 INCHES INTERMEDIATE SUPPORTS AND USE 8D COMMON NAILS FOR ROOF 6 INCHES FROM EDGES 12 INCHES INTERMEDIATE.

45. BUILDER/OWNER TO PROIVIDE WATERPROOFING TO CODE SUBMIT INFORMATION ON APPROVED 46. BUILDER/TRUSS MANUFACTURER TO PROVIDE TRUSS DESIGN DRAWINGS IN COMPLIANCE WITH MRC 2015 AND SHALL INCLUDE AT MINIMUM, THE INFORMATION SPECIFIED BELOW:

. SLOPE OR DEPTH, SPAN, AND SPACING LOCATION OF ALL JOINTS REQUIRED BEARING WIDTHS

4. DESIGN LOADS AS APPLICABLE 4a. TOP CHORD LIVE LOAD (INCLUDING SNOW LOADS) 4b. TOP CHORD DEAD LOAD

4c. BOTTOM CHORD LIVE LOAD

4d. BOTTOM CHORD DEAD LOAD

4e. CONCENTRATED LOADS AND THEIR POINTS OF APPLICATION

4f. CONTROLLING WIND AND EARTHQUAKE LOADS

5. ADJUSTMENTS TO LUMBER AND JOINT CONNECTOR DESIGN VALUES FOR EACH CONDITION

OF USE.
6. EACH REACTION FORCE AND DIRECTION 7. JOINT CONNECTOR TYPE AND DESCRIPTION (E.G., SIZE THICKNESS OR GAUGE) AND THE

DIMENSIONED LOCATION OF EACH JOINT CONNECTOR EXCEPT WHERE SYMMÉTRICALLY LOCATED RELATIVE TO THE JOINT INTERACE. 8. LUMBER SIZE, SPECIES, AND GRADE FOR EACH LUMBER

O. CONNECTION REQUIREMENTS FOR:

9a. TRUSS-TO-TRUSS GIRDER 9b. TRUSS PLY TO PLY

10. CALCLULATED DEFLECTION RATIO AND/OR MAX. DESCRIPTION FOR LIVE AND TOTAL LOAD.

11. MAX. AXIAL COMPRESSION FORCES IN THE TRUSS MEMBERS TO ENABLE THE BUILDING DESIGNER TO DESIGN THE SIZE CONNECTIONS AND ANCHORAGE OF THE PERMANENT CONDITIONS LATERAL BRACING. FORCES SHALL BE SHOWN ON THE TRUSS DRAWING OR ON SUPPLEMENTAL DOCUMENTS.

12. REQUIRED PERMANENT TRUSS MEMBER BRACING LOCATION. 47. ALL WINDER TREADS TO BE 6" WIDE (MIN.) AT INNER RADIUS AND 10" WIDE (MIN.) 12 INCHES FROM INNER RADIUS.

48. CARBON MONOXIDE DETECTORS TO BE PLACED 15 FEET MAXIMUM FROM A FUEL BURINING APPLIANCE. 49. ALL POURED CONCRETE FOUNDATION WALLS TO BE POURED IN VIBRATED 20-INCH LIFTS 50. ALL INTERIOR DIMENSIONS ARE TAKEN FROM GYPSUM UNLESS OTHERWISE NOTED. 51. ALL ATTIC SCUTTLES TO BE 1-HR. RATED AND CONFORM TO MUEC 2015.

52. AN AIR LEAKAGE TEST TO BE CONDUCTED PRIOR TO FINAL INSPECTION AND CONFORM TO MUEC 2015.


53. MIN (2) LAYERS UNDERLAYMENT ON PITCHED ROOFS 4:12 & UNDER 54. ALL INTERIOR WALL DIMENSIONS TAKEN FROM DRYALL UNLESS OTHERWISE NOTED 55. ALL INTERIOR FOUNDATION DIMENSIONS TAKEN FROM CONCRETE

56. ALL 2-STORY WALLS TO BE 2x6 CONSTRUCTION W/ (2) KING STUDS ON EACH SIDE OF WINDOW HEADER 57. BOTTOMS OF OPERABLE WINDOWS 72" OR MORE ABOVE FINISHED GRADE SHALL BE NO MORE THAN


58. ALL BEARING WALLS SHALL HAVE FLOOR JOISTS UNDER EACH BEARING STUD
59. PROVIDE LADDERS IN BASEMENT FOR ALL NON-BEARING WALLS PARALLEL TO FLOOR JOISTS THAT ARE

60. ALL BRANCH CIRCUITS THAT SUPPLY 125 VOLT SINGLE PHASE 15 & 20 AMPERE OUTLETS INSTALLED IN DWELLING UNIT BEDROOM SHALL BE PROTECTED BY ARC-FAULT CIRCUIT INTERRUPTER (AFCI) LISTED TO

PROVIDE PROTECTION IN THE ENTIRE CIRCUIT 61. ALL EXTERIOR WALLS TO BE 2x6 W/ R-19 BATT INSULATION CONSTRUCTION UNLESS NOTED OTHERWISE 62. ALL CANTILEVERED FLOORS TO BE INSULATED WITH MINIMUM R-30 BATT INSULATION

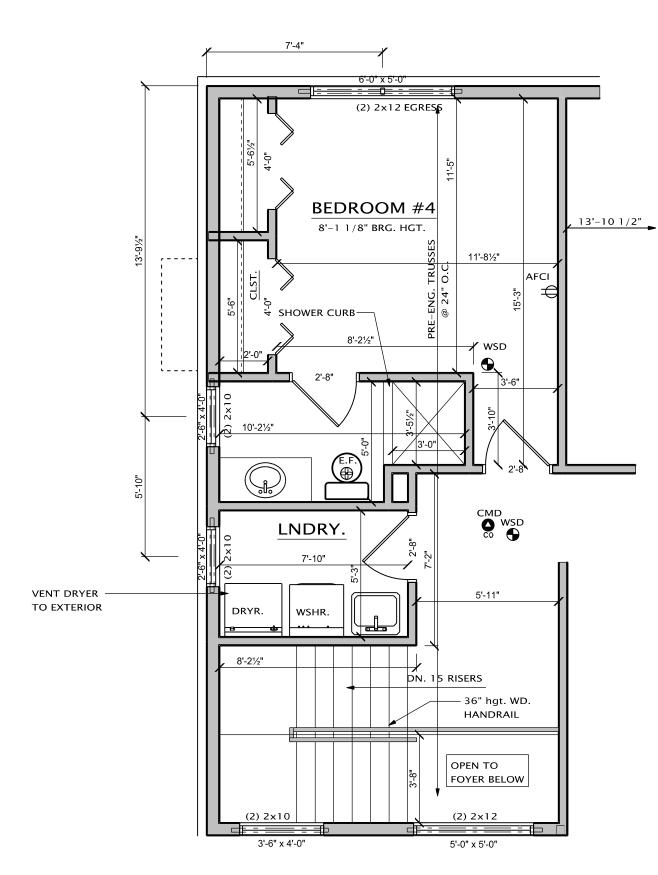

## OPTIONAL BEDROOM 4 W/ BATH

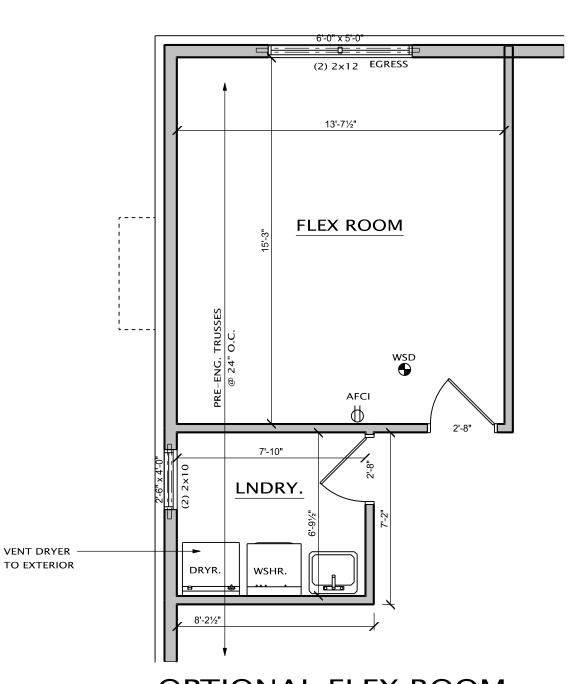

SCALE: 1/4" = 1'-0"




OPTIONAL—

SECOND SINK


OPTIONAL JACK & JILL BATH

BATH

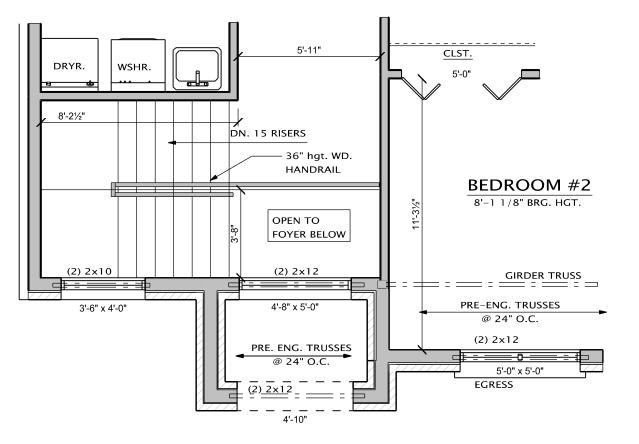

OPTIONAL COVERED PORCH

**ELEVATION B** 

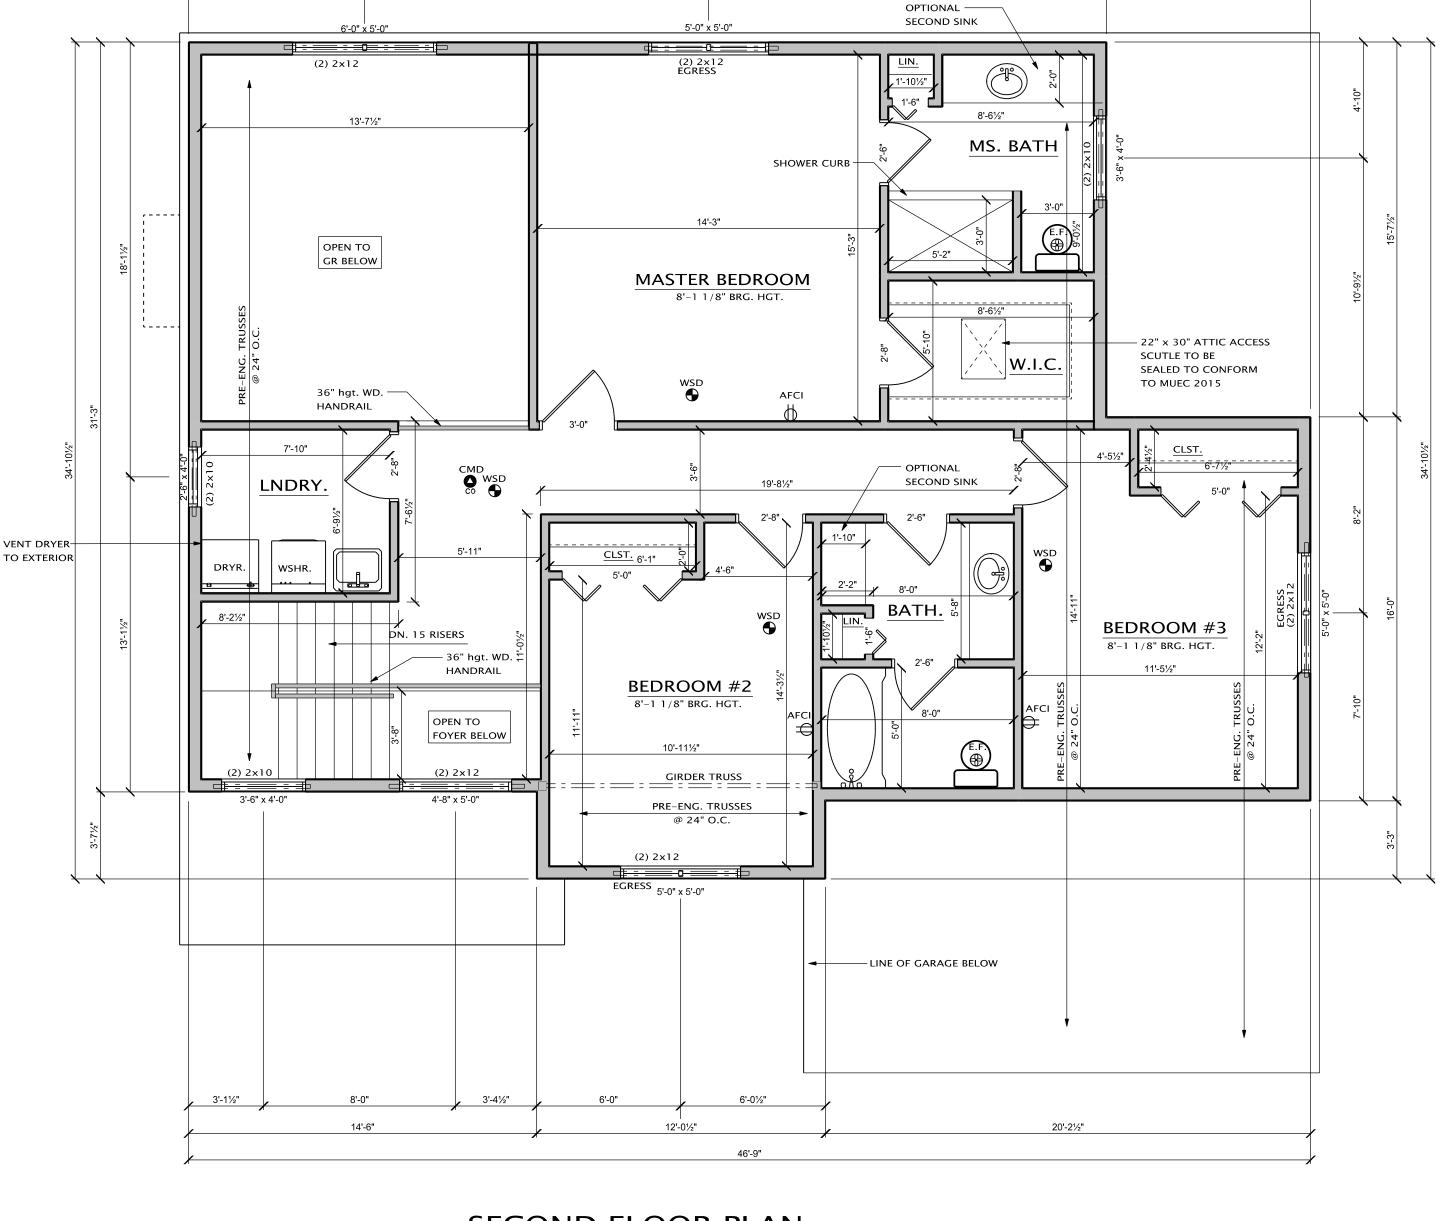

## SECOND FLOOR PLAN SCALE: 1/4'' = 1'-0''

**NOTE: EGRESS WINDOWS** EVERY SLEEPING ROOM SHALL HAVE AT LEAST ONE OPERABLE WINDOW OR EXTERIOR DOOR APPROVED FOR EMERGENCY ESCAPE OR RESUE. EACH EGRESS WINDOW SHALL HAVE A MINIMUM NET CLEAR OPENING OF 5.7 SQUARE FEET. THE NET CLEAR OPENING SHALL BE AT LEAST 24 INCHES IN HEIGHT AND AT LEAST 20 INCHES IN WIDTH. THE BOTTOM OF THE CLEAR OPENING SHALL NOT BE MORE THAN 44 INCHES ABOVE THE FLOOR. (EXCEPTION: THE MINIMUM NET CLEAR OPENING FOR GRADE FLOOR WINDOWS SHALL BE 5 SQUARE FEET.)

OPERABLE WINDOW NOTE: ALL WINDOWS THAT ARE OPERABLE AND THE BOTTOM OF THE WINDOW IS 72" OR MORE ABOVE GRADE, SHALL BE 24" ABOVE FINISH FLOOR TO THE BOTTOM OF THE WINDOW,

ALL FIRST FLOOR & SECOND FLOOR EXTERIOR WALLS TO BE 2X6 STUDS

ALL EXTERIOR WALLS TO BE 2X6 WALL CONST

**ELEVATION A** 

ALL BEARING WALLS SHALL HAVE FLOOR JOIST UNDER EACH BEARING STUD, TYP, ALL BEARING WALLS


PROVIDE 2x4 BLOCKING @ 16" O.C. BELOW ALL NON-BEARING WALLS THAT RUN PARALLEL TO FLR. JST AND ANY WALLS OVER 8'-0" IN HGT.

ALL INTERIOR DIMENSIONS TAKEN FROM DRYWALL

PROVIDE ALL ATTIC ACCESS J/ WEATHER STRIPPING ALL HEADERS TO BE 2x12


UNLESS NOTED OTHERWISE BEARING WALL TRUSS MANUFACTURER TO

DETERMINE HEEL HEIGHT

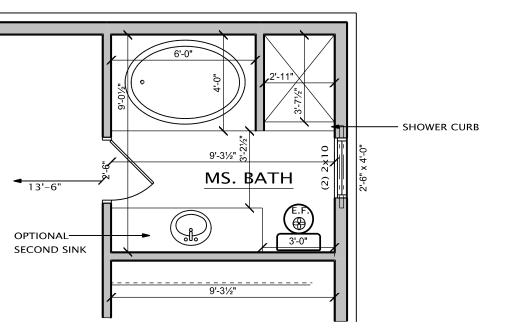

OPTIONAL MS. BATH

SCALE: 1/4" = 1'-0"

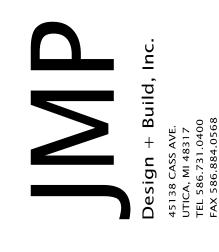

THE IDEAS AND DESIGN CONCEPTS EXPRESSED HEREIN AND THE GRAPH-ICALLY DISPLAYED ARRANGEMENT OF THEIR COMPONENTS REPRESENTED BY THIS DRAWING HAVE BEEN
DEVELOPED FOR THE EXCLUSIVE USE OF THE SPECIFIED PROJECT AND ARE THE SOLE PROPERTY OF JMP Design & Build, Inc.
INCORPORATED. A CONVEYANCE OR DISCLOSURE OF THE IDEAS DESIGN CONCEPTS OR USE OF ANY GRAPH-ICALLY DISPLAYED ARRANGEMENTS OF THE COMPONENTS SHALL BE AT THE DISCRETION AND ONLY THROUGH THE EXPRESSED WRITTEN CONSENT OF JMP Design & Build, Inc. ALL MATERIALS HEREIN ARE

PROJECT

BUILDER DEL VALLO BUILDING & CONSTRUCTION INC. 53750 N. FOSTER RD. CHESTERFIELD TWP. 48051 PH. 586-634-4429

PRELIMINARY CONSTRUCTION PERMIT

SHEET TITLE: SECOND FLOOR PLAN

DRAWN BY: 04-01-2021 04-07-2021 CHECKED BY: J.M.P. IOB NUMBER: 21 – 132 SHEET NUMBER: