

TREATED SILL PLATE -

9 6'-0" O.C. OR SIMPSON —— MABI5 STRAPS 9 42" O.C.

BOLT IN THE MIDDLE 1/3 OF BRACED WALL PANEL, MIN.

WOOD STRUCTURAL PANEL

USE ONLY IN CASES WHERE NO

WALL STRAP OR ANCHOR BOLT

IS PRESENT UNDER BRACED WALL

OVERLAP OPTION

T" EMBEDMENT, TYP,

10" FOUND, WALL

1/2" ANCHOR BOLTS

---3-16D @ 16" O.C. ALONG

BRACED WALL PANEL

-ADDITIONAL FRAMING

MEMBERS DIRECTLY

BELOW WALL PANEL

3-16D @ 16" O.C. ALONG

CONTINUOUS RIM

1/2" ANCHOR BOLTS @ 6'-0" O.C. OR SIMPSON MABI5 STRAPS @ 42" O.C.

NTS,

PARALLEL FRAMING DETAIL

OR BAND JOIST

BRACED WALL PANEL

TOE NAIL (3) 8D \_\_NAILS 2 1/2" LONG


PER JOIST,

EXTEND FULL SHEET OF

SHEATHING TO BOT, OF

- WOOD STRUCTURAL

JOIST BOND.

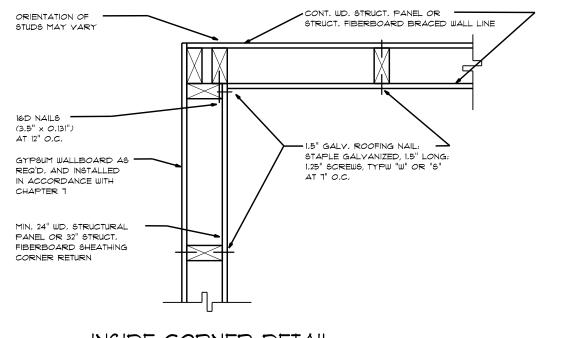

36" W.S.P. —

GARAGE WALLS THAT BEAR ON MASONRY BLOCK MUST

BRACED WALL PANEL,

HAVE \* 4 BARS EMBEDDED INTO CONC. MIN. OF 6" @ 32" O.C.

**---**36" ₩.S.P.

SECOND FLOOR PLAN

PROVIDE (2) FULL-

ON EACH SIDE OF


WINDOW HEADERS

LENGTH STUDS

METHOD:	w.s.p.	CONNECTION CRITERIA					
MATERIAL	WOOD STRUCTURAL PANEL	MINIMUM NAIL		NOMINAL PANEL	MAX. WALL STUD	PANEL NAIL SPACING	
		SIZE	PEN, (in.)	THICKNESS	SPACING (in.)	EDGES	ELSEWHERE
MINIMUM THICKNESS	3/8"	6D COMMON (2" × 0.113")	1.5	3/8"	16	(in. O.C.)	(in. O.C.)
						6	12
OPTIONAL	7/16"	8D COMMON (2.5" × 0.131")	1.5	7/16"	16	6	12
					24	6	12
METHOD:	LET IN BRACING	WOOD: 2-8d METAL: PER MANUFACTURER PER STUD INCLUDING OR 1x4 (45 DEG. OR 60 DEG. ♥ 16" O.C.) TOP & BOTTOM PLATE					6" O.C.)
METHOD:	1/2" GYP. EACH SIDE OF WALL	GYPSUM BOARD ON BOTH SIDES OF WALL NAILS OR SCREWS @ 7" SPACING AT PANEL EDGES INCLUDING TOP AND BOTTOM PLATES AND ALL INTERMEDIATE POINTS.					

FIRST FLOOR PLAN

SCALE: 1/8" = 1'-0"

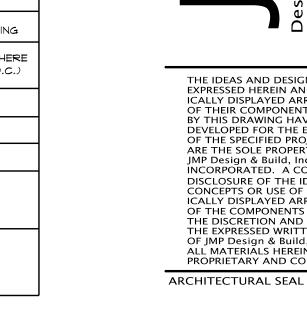

THE IDEAS AND DESIGN CONCEPTS

EXPRESSED HEREIN AND THE GRAPH-ICALLY DISPLAYED ARRANGEMENT

OF THEIR COMPONENTS REPRESENTED BY THIS DRAWING HAVE BEEN

DEVELOPED FOR THE EXCLUSIVE USE OF THE SPECIFIED PROJECT AND

INCORPORATED. A CONVEYANCE OR DISCLOSURE OF THE IDEAS DESIGN

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OF THE COMPONENTS SHALL BE AT

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PRELIMINARY CONSTRUCTION (

SHEET TITLE: BRACED WALL PLAN


PERMIT

METHOD CS-PF

DATE:	DRAWN BY:		
05-01-2017 05-08-2017	J.V.C.		
	CHECKED BY:		
	J.M.P.		
	JOB NUMBER:		

SHEET NUMBER:

17 - 164

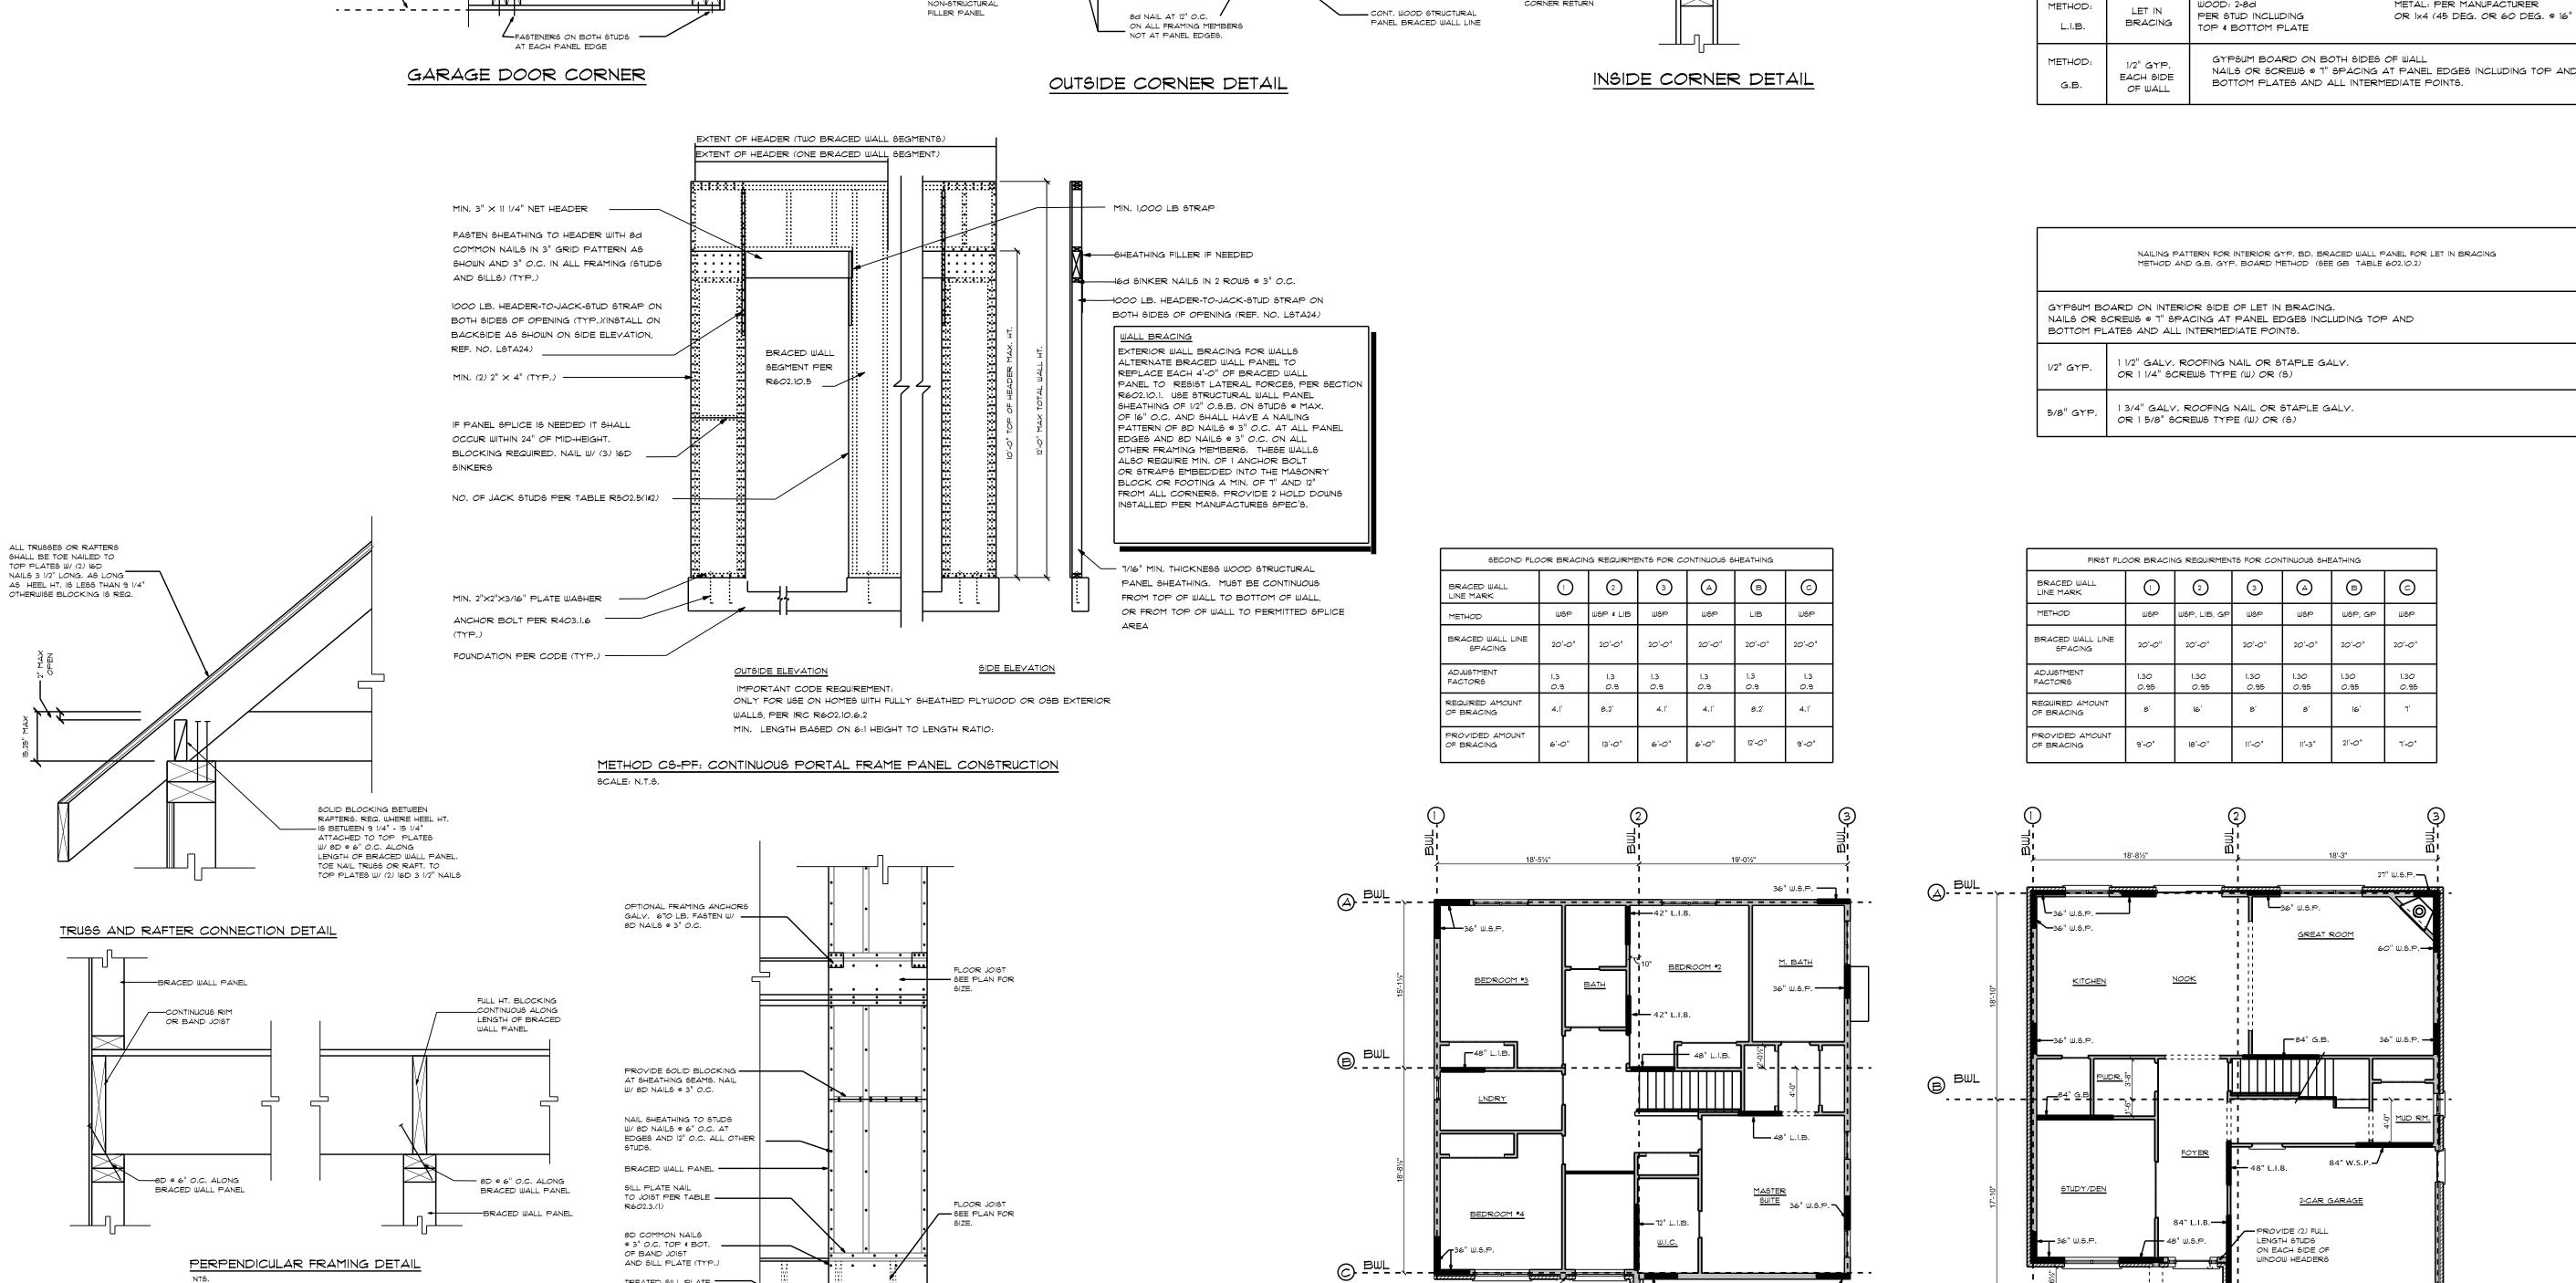

NOTE: ALL BRACED WALL PANELS MUST BE

ANCHORED TO TRUSSES AND FLOOR SYSTEM ABOVE AND BELOW. ANCHOR

BLOCK WALL WITH 1/2" ANCHOR BOLTS

IN THE MIDDLE 1/3 OF PANEL, MIN, OF

BRACED WALL PANELS TO CONCRETE OR

7" OF EMBEDMENT, SEE DETAIL THIS SHEET