CODE COMPLIANCE

GENERAL NOTES:

(REFER TO NOTES ONLY APPLICABLE TO PROJECT) ALL NOTES TO COMPLY WITH: MICHIGAN RESIDENTIAL CODE 2015

MICHIGAN PLUMBING CODE 2015 MICHIGAN MECHANICAL CODE 2015 NATIONAL ELECTRICAL CODE 2014 MICHIGAN UNIFORM ENERGY CODE 2015

1. 2x10 FLOOR JOISTS @ 12" O.C. UNDER ALL THE TILE OR MARBLE FLOORS

20 LB. DEAD LOAD REQUIRED 2. ALL POURED CONCRETE WALLS TO BE BACKFILLED WITH SANDY TYPE

SOIL AND BE WELL BRACED UNTIL CONCRETE IS THOROUGHLY CURED AND ADDITIONAL WEIGHT OF THE BUILDING IS IN PLACE. 3. ALL FLOOR JOISTS TO BE #2 OR BETTER HEM FIR W/ 1"x3" CROSS BRIDGING

4. ROOF TRUSS DESIGNED BY TRUSS MANUFACTURER TO CONFORM TO ALL MINIMUM DESIGN LOAD REQUIREMENTS. BRACE ROOF TRUSSES AS REQUIRED

5. ROOF TRUSS FRAMING INDICATING ON DRAWINGS ON DRAWINGS IS ARE ASSUMED. LAYOUT, TRUSS MANUFACTURER SHOULD REVIEW THE DRAWING AND INDICATE TO ARCHITECT/DESIGNER PRIOR TO FABRICATION ANY CHANGE IN BEARING CON-DITIONS THAT WOULD REQUIRE RE-FRAMING OF OUR STRUCTURE TO ACCOMODATE

6. ALL POURED CONCRETE FOOTINGS TO BE A MINIMUM OF 3'-6" BELOW FINISHED GRADE BEARING ON UNDISTURBED VIRGIN SOIL WITH A MINIMUM BEARING CAPACITY OF 2,000 PSF MUST BE VERIFIED BY SOILS ENGINEER IN THE FIELD FOR FOOTING

7. ALL POURED CONCRETE WALLS WITH 7'-0" OR MORE BACKFILL TO BE REINFORCED

WITH #4 BARS @ 16" O.C. VERTICALLY WITH ONE #4 BAR TOP & BOTTOM OF WALL HORIZONTALLY, FOOTING INSPECTOR TO VERIFY IN FIELD. 8. ALL WINDOW NUMBERS REFER TO ANDERSON 100 SERIES WINDOWS. IF ALTERNATE

WINDOW MANUFACTURER IS USED, ALL SIZES & SHAPES TO MATCH DIMENSIONALLY 9. ALL ENGINEERED WOOD FLOOR TRUSSES TO BE #1 DENSE K.D. WITH 2" BY 6" CON-FINUOUS RIBON BRACING ON BOTTOM CHORD 8'-0" O.C. (MINIMUM 2 PER SPAN) WELL

NAILED TO TRUSSES. PROVIDE DRAFT STOPPING. 10. THE ROOF TRUSS MANUFACTURER TO FURNISH SHOP DRAWING TO THE ARCHITECT/ DESIGNER PRIOR TO FABRICATION OF THE TRUSSES.

1. ALL MICRO-LAM BEAMS TO BE JOINED TOGETHER PER MANUFACTURERS' SPECIFICAIONS. 12. ALL POURED CONCRETE WALLS WITH BRICK LEDGE GREATER THAN 4'-0" SHALL BE RE-INFORCED WITH #5 BARS 24" O.C. VERTICALLY WITH ONE #4 BAR TOP & BOTTOM OF WALL

13 DO NOT SCALE DRAWINGS USE PRINTED DIMENSIONS ONLY JE ANY DISCREPANCY OCCURS, NOTIFY THE ARCHITECT/DESIGNER IMMEDIATELY FOR DIRECTION. THE BUILDER IS RESPONSIBLE FOR REVIEWING ALL DRAWINGS AND IF ADDITIONAL CLARIFICATION OR INFORMATION IS NEEDED, BUILDER IS TO CONTACT THE ARCHITECT/DESIGNER AND SALES

14. PROVIDE 15 POUND FELT AT UNTREATED EXPOSED LUMBER. 15. ALL BEDROOM WINDOWS TO MEET 2015 MICHIGAN RESIDENTIAL EGRESS CODES. ALL WINDOW

SILLS 72" ABOVE FINISH GRADE. SHALL AHVE THE BOTTOM F THE OPENING LOCATED A MINIMUM OF 24" ABOVE FINISH FLOOR OF THE ROOM PER MRC 2015 16. PROVIDE FIBER CEMENT, FIBER MAT REINF. CEMENT, GLASS MAT GYPSUM BACKERS OR FIBER REINE, GYPSUM BACKERS AS BACKERS FOR TUB AND/OR SHOWER WALL

FILES AND PANELS. BACKERS MUST COMPLY WITH ATSM C1288, C 1325, C1178 AND BE INSTALLED PER MANUFACTURERS' RECOMMENDATIONS 17. WHERE HANDRAILS ARE SHOWN, HANDRAIL HEIGHTS ARE TO NOT BE LESS THAN 34" A.F.F. & MORE THAN 38" A.F.F. GUARD RAIL IS TO BE NOT LESS THAN 36" A.F.F. (MRC 2015) PROVIDE HANDRAIL ON AT LEAST (1) SIDE OF EVERY STAIRWAY PER SECTION R311.7.7 OF THE 2015 MICHIGAN RESIDENTIAL CODE. HANDRAIL GRIP TO COMPLY WITH 2015 MICHIGAN

RESIDENTIAL CODE. 18. DO NOT DRILL KITCHEN WINDOW DOUBLERS.

19. PROVIDE A BATH FAN WHERE SHOWN ON PLAN AND VENT FAN TO EXTEIOR AS REQUIRED.
20. TYPICAL ALL HABITABLE ROOMS TO HAVE PROPER LIGHT AND VENTILATION AND COMPLY WITH 2015 MICHIGAN RESIDENTIAL CODES.

21. PROVIDE ELECTRICAL SMOKE DETECTORS IN ALL SLEEPING AREAS, HALLWAYS, AND MECHANICAL ROOMS ON ALL FLOOR LEVELS, INCLUDING THE BASEMENT, SMOKE DETECTORS SHALL BE WIRED TOGETHER SO AS WHEN ONE SOUNDS, THEY ALL SOUND AND HAVE BATTERY BACKUP PER

SEC 314 OF 2015 MICHIGAN RESIDENTIAL CODE. 22. PROVIDE ADEQUATE ROOF VENTILATION AND SOFFIT VENTILATION (MIN.) AS REQUIRED. VERIFIED BY CALCULATION 1/300 OF THE AREA VENTILATION REQUIRED.

23. TYPICALLY ALL PINS IN POURED CONCREETE FOUNDATION WALLS MUST BE REMOVED AND FILLED WITH FOUNDATION COATING PRIOR TO BACK FILL INSPECTION. 24. PROIVDE METAL FLASHING, COUNTER FLASHING AND STEPPED FLASHING WHERE NOTED AND

25. PROVIDE APPROVED SEALANT WHERE REQUIRED AND AS DETAILED BY MANUFACTURER. 26. VERIFY ELECTRICAL SERVICE IN ACCOMMODATING ALL NEW WORK, VERIFY ALL PROPOSED ELECTRICAL OUTLETS, SWITCHES, DIMMERS, LIGHT LOCATION, ETC. INCLUDING CABLE AND

PHONE PRE-WIRING SECURITY. TAKE INTO CONSIDERATION ALL ELECTRICAL INSTALLATION WITH OWNER AND COMPLY WITH 2015 MICHIGAN RESIDENTIAL ELECTRICAL CODES. 7. VERIFY FIREPLACE OPTION WITH SUBDIVISION SPECS. AND WORK ORDER. 28. PROVIDE 2-LAYER MINERAL COATED ROLLED ROOFING AT ALL EAVES TO 24" INSIDE BULIDING.

2-I AYERS MUST BE CEMENTED TOGETHER VERIEV WITH BUILDING DEPARTMENT 29. PROVIDE 2x6 WOLMANIZED PRESSURE TREATED SILL PLATE ON FIBERGLASS SILL SEALER WITH 1/2 INCH ANCHOR BOLTS AT 6'-0" O.C. AND LOCATED NOT MORE THAN 12" INCHES AND NOT LESS THAN 3-1/2 INCHES FROM THE ENDS OF EACH PLATE SECTION. EXCEPTION: USE ANCHOR

STRAPS SPACED AT 3'-6" O.C. TO PROVIDE FOUIVALENT ANCHORAGE TO 1/2" ANCHOR BOLTS 30. PROVIDE 4" PERIF. DRAIN TILE CONT. AT BASEMENT/CRAWL SPACE FOOTING IN 12" (MIN) PEASTONE W/ 2" BELOW DRAIN TILE. CONNECT TO SUMP AND STORM SEWER AS REQUIRED.

31. 6'-8" CLEAR HEADROOM REQUIRED ON ALL STAIRS. CHIMNEY TERMINATION MUST PROJECT 2 FEET ABOVE ANY PART OF THE BULDING WITHIN

33. FIRESTOP ALL DROPS AND CHASES, ELECTRICAL, PLUMBING AND H.V.A.C. 34. PROVIDE 1/2 INCH DRYWALL ON THE GARAGE SIDE OF WALLS COMMON TO RESIDENCE

HABITABLE ROOMS PER MRC 2015. 35. LOWER LEVEL AREA CONSIDERED UNHABITABLE. ANY FUTURE MODERATIONS TO MODIFY

LOWER LEVEL TO A HABITABLE SPACE WILL COMPLY STRICLY TO THE 2015 MRC. EGRESS WINDOW(S) PROVIDED AS REQUIRED IN COMPLIANCE WITH MRC 2015.

36. AREAS THAT REQURE TEMPERED GLASS: A. FIXED AND SLIDING PANELS OF SLIDING TYPE DOORS

B. SHOWER AND BATHTUB DOORS AND ENCLOSURES (IF APPLICABLE)
C. PANELS WITH A GLAZED AREA IN EXCESS OF 9 SQ. FT. WITH LOWEST RIDGE LESS THAN 18 INCHES ABOVE THE FINISHED FLOOR LEVEL.

D. ALL OTHER AREAS AS CODE REQUIRES PER 2015 MR 37. ROOF VENTILATION WHERE EAVE OR CORNICE VENTS ARE INSTALLED INSULATION SHALL NOT BLOCK THE FREE FLOW OF AIR. A MINIMUM OF A 1 INCH SPACE SHALL BE PROVIDED

BETWEEN THE INSULATION AND THE ROOF SHEATHING AT THE LOCATION OF THE VENTS. 38. ALL STAIRWAYS SHALL BE ILLUMATED WITH MIN (1) FOOT CANDLE OF LIGHT. 39. PROVIDE UNDERSTAIR PROECTION PER MRC 2015 ENCLOSED ACCESIBLE SPACE UNDER

SHALL HAVE WALLS, UNDER STAIR SURFACE AND ANY SOFFITS PROTECTED ON THE ENCLOSED SIDE WITH 1/2 INCH GYPSUM BOARD. 40. UNEXCAVATED GARAGE SLAB SHALL COMPLY WITH TABLE R402.2 4 INCH CONCRETE SLAB

MIN. 3,500 MINIMUM SPECIFIED COMPRESSIVE STRENGTH OF CONCRETE ON 4 INCHES MIN. WELL COMPACTED SAND BASE 41. PROVIDE NON-ABSORBENT FINISH, TO THE SURFACE OF ALL BATHING AREAS WITH WALL

MOUNTED SHOWER HEADS, A MIN. 6'-0" ABOVE FINISH FLOOR PER MRC 2009 SEC. R307.2 42. PROVIDE A 1-3/8 INCH MIN. SOLID CORE FIRERATED DOOR BETWEEN GARAGE AND RESIDENCE

MIN. 20 MINUTE FIRERATED. 43. BUILDER AND SUB-BRICK CONTRACTORS TO PROVIDE WEEP HOLES RESTING ON THE FLASHING SPACED 32" O.C. MAX. (24 INCHES PREFERRED) AT THEAD DETAILS OF: WINDOWS, DOORS, BASEMENT WINDOWS AND GARAGE DOORS. ALSO PROVIDE FLASHING TO FACE OF BRICK WITH MIN. 8 INCHES VERTICAL LEG AND FORM END DAMS (LAP UNDER AIR/MOISTURE BARRIER).

MICHIGAN RESIDENTIAL CODE 2015. A PRE-BRICK INSPECTION WILL BE REQUIRED PRIOR TO BRICK INSTALLATION FOR FLASHING INSPECTION. 44. FASTENER SCHEDULE FOR STRUCTURAL MEMBERS TABLE R602.3 (1) WOOD STRUCTURAL PANELS, SUBFLOOR, ROOF AND WALL SHEATHING TO FRAMING, BUILDING MATERIALS OF 5/16 INCHES TO 1/2 INCHES USE 6D COMMON NAIL (SUBFLOOR, WALL) AT 6 INCHES FROM EDGES

12 INCHES INTERMEDIATE SUPPORTS AND USE 8D COMMON NAILS FOR ROOF 6 INCHES FROM EDGES 12 INCHES INTERMEDIATE.

45. BUILDER/OWNER TO PROIVIDE WATERPROOFING TO CODE SUBMIT INFORMATION ON APPROVED PRODUCTS. 46. BUILDER/TRUSS MANUFACTURER TO PROVIDE TRUSS DESIGN DRAWINGS IN COMPLIANCE WITH MRC 2015 AND SHALL INCLUDE AT MINIMUM, THE INFORMATION SPECIFIED BELOW:

2. LOCATION OF ALL JOINTS REQUIRED BEARING WIDTHS 4. DESIGN LOADS AS APPLICABLE

1. SLOPE OR DEPTH, SPAN, AND SPACING

4a. TOP CHORD LIVE LOAD (INCLUDING SNOW LOADS)

4d. BOTTOM CHORD DEAD LOAD 4e. CONCENTRATED LOADS AND THEIR POINTS OF APPLICATION

53. MIN (2) LAYERS UNDERLAYMENT ON PITCHED ROOFS 4:12 & UNDER

4f. CONTROLLING WIND AND EARTHQUAKE LOADS
5. ADJUSTMENTS TO LUMBER AND JOINT CONNECTOR DESIGN VALUES FOR EACH CONDITION

6. EACH REACTION FORCE AND DIRECTION
7. JOINT CONNECTOR TYPE AND DESCRIPTION (E.G., SIZE THICKNESS OR GAUGE) AND THE DIMENSIONED LOCATION OF EACH JOINT CONNECTOR EXCEPT WHERE SYMMETRICALLY

LOCATED RELATIVE TO THE JOINT INTERACE. 8. LUMBER SIZE, SPECIES, AND GRADE FOR EACH LUMBER

9. CONNECTION REQUIREMENTS FOR a. TRUSS-TO-TRUSS GIRDER 9b TRUSS PLY TO PLY

4c BOTTOM CHORD LIVE LOAD

9c. FIELD SPLICES 10. CALCLULATED DEFLECTION RATIO AND/OR MAX. DESCRIPTION FOR LIVE AND TOTAL LOAD 1. MAX. AXIAL COMPRESSION FORCES IN THE TRUSS MEMBERS TO ENABLE THE BUILDING DESIGNER TO DESIGN THE SIZE CONNECTIONS AND ANCHORAGE OF THE PERMANENT CONDITIONS LATERAL BRACING. FORCES SHALL BE SHOWN ON THE TRUSS DRAWING OR

ON SUPPLEMENTAL DOCUMENTS. 12. REQUIRED PERMANENT TRUSS MEMBER BRACING LOCATION. 47. ALL WINDER TREADS TO BE 6" WIDE (MIN.) AT INNER RADIUS AND 10" WIDE (MIN.) 12 INCHES

48. CARBON MONOXIDE DETECTORS TO BE PLACED 15 FEET MAXIMUM FROM A FUEL BURINING APPLIANCE. 49. ALL POURED CONCRETE FOUNDATION WALLS TO BE POURED IN VIBRATED 20-INCH LIFTS 50. ALL INTERIOR DIMENSIONS ARE TAKEN FROM GYPSUM UNLESS OTHERWISE NOTED. 51. ALL ATTIC SCUTTLES TO BE 1-HR. RATED AND CONFORM TO MUEC 2015. 52. AN AIR LEAKAGE TEST TO BE CONDUCTED PRIOR TO FINAL INSPECTION AND CONFORM TO MUEC 2015.

54. ALL INTERIOR WALL DIMENSIONS TAKEN FROM DRYALL UNLESS OTHERWISE NOTED 55. ALL INTERIOR FOUNDATION DIMENSIONS TAKEN FROM CONCRETE 56. ALL 2-STORY WALLS TO BE 2x6 CONSTRUCTION W/ (2) KING STUDS ON EACH SIDE OF WINDOW HEADER

57. BOTTOMS OF OPERABLE WINDOWS 72" OR MORE ABOVE FINISHED GRADE SHALL BE NO MORE THAN 24" ABOVE FINISHED FLOOR 58. ALL BEARING WALLS SHALL HAVE FLOOR JOISTS UNDER EACH BEARING STUD

59. PROVIDE LADDERS IN BASEMENT FOR ALL NON-BEARING WALLS PARALLEL TO FLOOR JOISTS THAT ARE 8'-0" LONG OR LONGER

60. ALL BRANCH CIRCUITS THAT SUPPLY 125 VOLT SINGLE PHASE 15 & 20 AMPERE OUTLETS INSTALLED IN

62. ALL CANTILEVERED FLOORS TO BE INSULATED WITH MINIMUM R-30 BATT INSULATION

DWELLING UNIT BEDROOM SHALL BE PROTECTED BY ARC-FAULT CIRCUIT INTERRUPTER (AFCI) LISTED TO PROVIDE PROTECTION IN THE ENTIRE CIRCUIT 61. ALL EXTERIOR WALLS TO BE 2x6 W/ R-21 BATT INSULATION CONSTRUCTION UNLESS NOTED OTHERWISE

NOTE: EGRESS WINDOWS

EVERY SLEEPING ROOM SHALL HAVE AT LEAST ONE OPERABLE WINDOW OR EXTERIOR DOOR APPROVED FOR EMERGENCY ESCAPE OR RESUE. EACH EGRESS WINDOW SHALL HAVE A MINIMUM NET CLEAR OPENING OF 5.7 SQUARE FEET. THE NET CLEAR OPENING SHALL BE AT LEAST 24 INCHES IN HEIGHT AND AT LEAST 20 INCHES IN WIDTH. THE BOTTOM OF THE CLEAR OPENING SHALL NOT BE MORE THAN 44 INCHES ABOVE THE FLOOR. (EXCEPTION: THE MINIMUM NET CLEAR OPENING FOR

GRADE FLOOR WINDOWS SHALL BE 5 SQUARE FEET.)

SMOKE DETECTORS & CARBON MONOXIDE DETECTOR

SMOKE ALARMS SHALL BE INSTALLED IN THE FOLLOWING LOCATIONS:

-IN EACH SLEEPING ROOM -OUTSIDE EACH SEPARATE SLEEPING AREA IN THE IMMEDIATE VICINITY

OF THE BEDROOMS -ON EACH ADDITIONAL STORY OF THE DWELLING, INCLUDING BASEMENTS BUT NOT INCLUDING CRAWL SPACES OR UNINHABITABLE

ALL SMOKE DETECTORS SHALL BE INTERCONNECTED AN HAVE A BATTERY BACKUP

CARBON MONOXIDE DETECTORS SHALL BE LOCATED IN THE NEAR VICINITY OF EACH BEDROOM AND IN BASEMENT 15'-0" FROM FUEL

FIRED OR HEATED UNIT HARD WIRED AND BATTERY BACK-UP. BACK UP

MRC 2015 SEC R 315

NOTE: PROVIDE TEMPERED GLASS

1. WHEN GLASS IS 18" OR LOWER A.F.F. 2. ANY DOOR THAT HAS GLASS CONSTRUCTION

3. WITHIN 36" OF A DOOR OR SWING 4. WITHIN THE NEAR VACINITY OF TUB OR SHOWER AND LESS THAN 60"

FROM FLOOR OR PLATFORM SURFACE. 5. WINDOWS IN STAIR LANDINGS 60" OR LESS A.F.F.

ARCH FAULT CIRCUIT INTERRUPTER

ALL BRANCH CIRCUITS THAT SUPPLY 125 VOLT SINGLE PHASE 15 & 20 AMP. OUTLETS INSTALLED IN DWELLING UNIT BEDRM. SHALL BE PROTECTED BY ARC-FAULT CIRCUIT INTERRUPTER LISTED TO PROVIDE PROTECTION IN THE ENTIRE CIRCUIT E3802.11.

OPERABLE WINDOW NOTE:

ALL WINDOWS THAT ARE OPERABLE AND THE BOTTOM OF THE WINDOW IS 72" OR MORE ABOVE GRADE, SHALL BE 24" ABOVE FINISH FLOOR TO THE BOTTOM OF THE WINDOW

> NOTE TO TRUSS COMPANY: ALL TRUSS BEARING TO BE TRANSFERD TO EXTERIOR WALLS W/ GIRDER TRUSSES.

CIRCULATING HOT WATER SYSTEMS:

NO INTERIOR WALL BEARING

THE SYSTEM IS NOT IN USE.

ALL CIRCULATING SERVICE HOT WATER PIPING HALL INCLUDE AN AUTOMATIC OR READILY ACCESSIBLE MANUAL SWITCH THAT CAN TURN OFF THE HOT WATER CIRCULATING PUMP WHEN

ALL EXTERIOR WALLS TO BE 2X6 WALL CONST

ALL INTERIOR DIMENSIONS TAKEN FROM DRYWALI

ROVIDE ALL ATTIC ACCESS W/ WEATHER STRIPPING

ALL HEADERS TO BE (2) 2x10 UNLESS NOTED OTHERWISE

ALL BEARING WALLS SHALL HAVE FLOOR JOIST

UNDER EACH BEARING STUD. TYP. ALL BEARING WALLS

PROVIDE 2x4 BLOCKING @ 16" O.C. BELOW ALL NON-BEARING WALLS THAT RUN PARALLEL TO FLR. JST AND ANY WALLS OVER 8'-0" IN HGT.

ALL WALLS OVER 10'-0" IN HEIGHT HAVE BEEN ANALYISED FOR LATERAL WIND LOADS AND SHEAR. THE WALLS ARE STRUCTURAL DESIGNED WITH 7/16" O.S.B. AND USE 8D NAILS OR EQUIVALENT STAPLES @ 8" O.C. ON ALL STUDS AND BLOCKING.

GENERAL NOTES

ALL WORK TO COMPLY WITH ALL NATIONAL, STATE AND LOCAL CODES, ORDINANCES, LAWS AND REGULATIONS THAT

ARE APPLICABLE. THE CONTRACTOR SHALL NOTIFY MISS DIG (1-800-482-7171)

AT LEAST 72 HOURS PRIOR TO THE START OF CONSTRUCTION. THE CONTRACTOR SHALL OBTAIN ALL REQUIRED PERMITS AND CALL FOR REQUIRED INSPECTIONS.

THE CONTRACTOR SHALL FIELD VERIFY THE SIZES, LOCATIONS, ELEVATIONS AND DETAILS OF THE EXISTING CONDITIONS THAT AFFECT THE WORK AND SHALL INFORM THE ARCHITECT OF ANY DISCREPANCIES IN DIMENSIONS, SIZES, LOCATIONS AND


CONDITIONS BEFORE PROCEEDING WITH THE WORK. THE CONTRACTOR SHALL PROVIDE ALL SHORING, BRACING, AND UNDERPINNING AND ALL MEANS REQUIRED TO PROTECT AND MAINTAIN THE SAFETY, INTEGRITY AND STABILITY OF ALL NEW

THE CONTRACTOR SHALL FAMILIARIZE HIMSELF/HERSELF WITH THE EXISTING CONDITIONS OF THE BUILDING INCLUDING UTILITIES, SERVICES, ETC. AND SHALL BE FULLY RESPONSIBLE FOR ANY UNAUTHORIZED DISRUPTION TO THE OWNER'S NORMAL USE OF

UTILITIES, SERVICES, AND THE SURROUNDING FACILITIES. HE CONTRACTOR/OWNER SHALL FAMILIARIZE HIMSELF/HERSELF WITH THE CONSTRUCTION DOCUMENTS, SIZES AND LOCATIONS OF

ANY DISCREPANCIES IN DIMENSIONS, SIZES AND LOCATIONS BEFORE PROCEEDING WITH THE WORK. THE CONTRACTOR/OWNER SHALL INDEMNIFY THE ARCHITECT

FROM ERRORS AND OMISSIONS WHICH CAN OR MAY OCCUR DURING THE PREPERATION OF THESE DOCUMENTS.

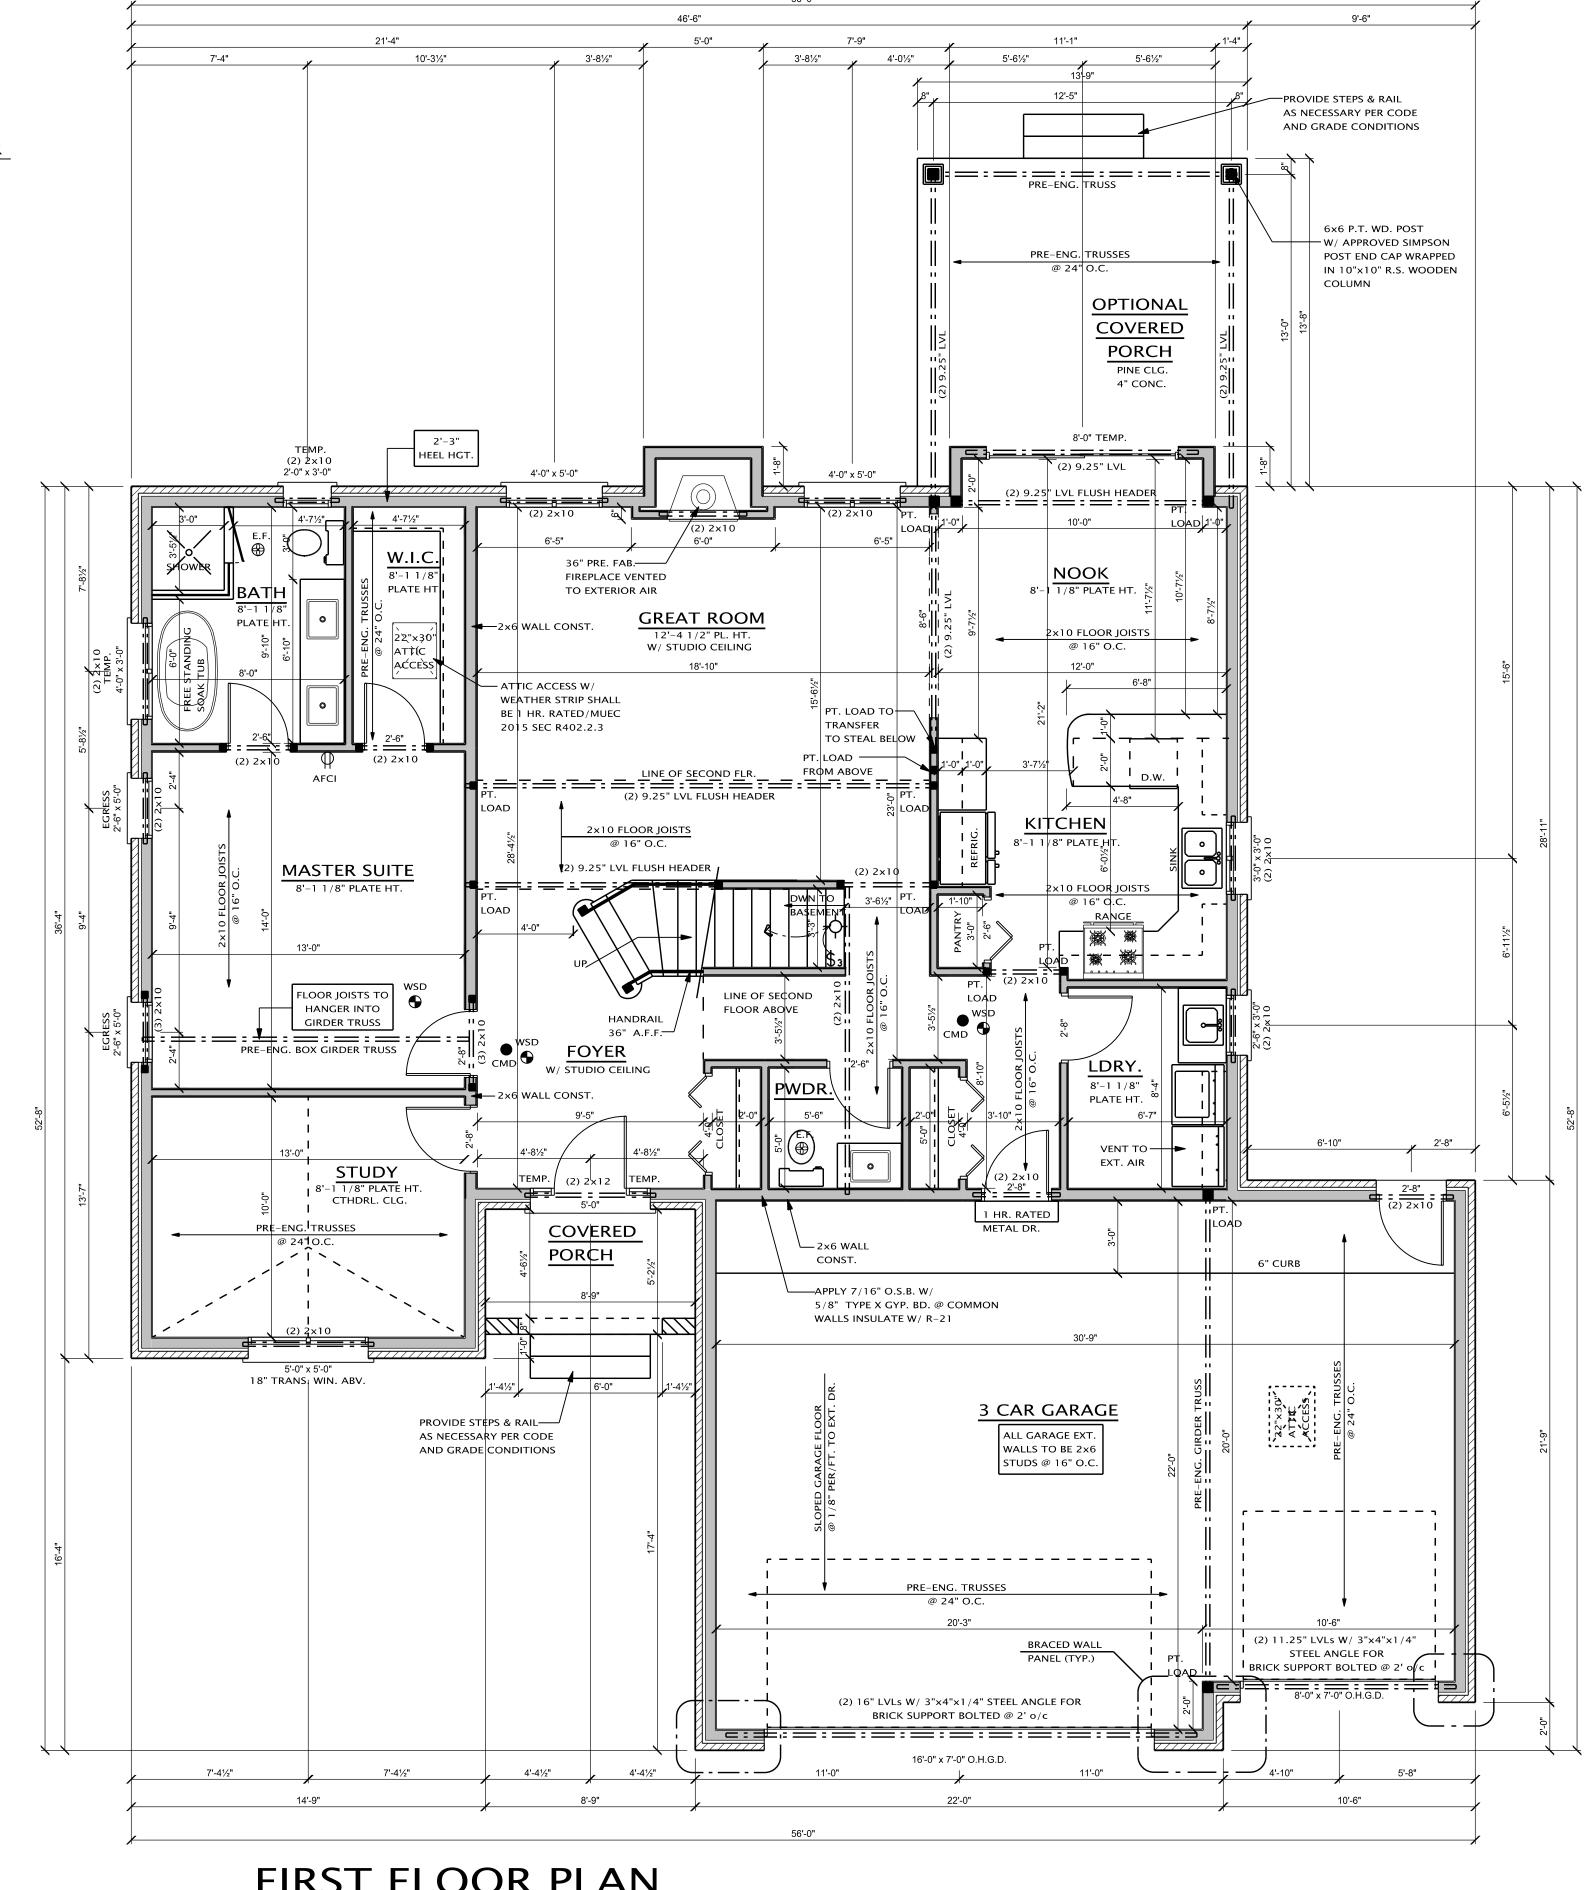

FIRST FLOOR PLAN SCALE: 1/4" = 1'-0"

2ND FLOOR: 755 S.F.

TOTAL: 2,255 S.F.

THE IDEAS AND DESIGN CONCEPTS EXPRESSED HEREIN AND THE GRAPH-ICALLY DISPLAYED ARRANGEMENT OF THEIR COMPONENTS REPRESENTED BY THIS DRAWING HAVE BEEN DEVELOPED FOR THE EXCLUSIVE USE OF THE SPECIFIED PROJECT AND ARE THE SOLE PROPERTY OF JMP Design & Build, Inc. INCORPORATED. A CONVEYANCE OR DISCLOSURE OF THE IDEAS DESIGN ICALLY DISPLAYED ARRANGEMENTS OF THE COMPONENTS SHALL BE AT THE DISCRETION AND ONLY THROUGH THE EXPRESSED WRITTEN CONSENT OF JMP Design & Build, Inc. ALL MATERIALS HEREIN ARE PROPRIETARY AND COPYWRITTEN ARCHITECTURAL SEAL

PROJECT

BUILDER / CLIENT CONSTRUCTION

PRELIMINARY CONSTRUCTION

FLOOR PLAN

SHEET TITLE:

DATE: DRAWN BY: 02-24-2023 J.V.C. 03-01-2023 03-13-2023 CHECKED BY: J.M.P. JOB NUMBER: 23 – 119

SHEET NUMBER: